STEVENS CREEK RESIDENTIAL













Acclaim COMPANIES



MULTI ERTINO CUP SCB

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(510) 451 - 2850

Sheet Title: COVER SHEET

Job No. Scale: Drawn By: Author

23004 9/26/2023

Sheet No:

PROJECT SUMMARY

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ADDRESS: SITE AREA: ASSESSOR'S PARCEL NUMBER: ZONING: EXISTING USE: PROPOSED USE: OVERLAY: CONSTRUCTION TYPE:	1.63 ACRES 316-23-093 P (CG, RES) COMMERCIAL MULTI-FAMILY RESID CP - HEART OF THE	CITY SPECIFIC PLAN ENS CREEK BOULEVARD JBTERRANEAN)		
OCCUPANCY GROUP:	R-2 - RESIDENTIAL B - LEASING OFFIC A - FITNESS, CLUE S-2 - GARAGE			
SETBACK REQUIRED STREET FRONT: 35'		SETBACK PROVIDED PRIMARY FRONTAGE:	30'	, E (
STREET SIDE: 35' (RECOMMENI	D BUT NOT REQUIRED)	STREET SIDE.	15'	

STREET FRONT:	35'	PRIMARY FRONTAGE:	30'
STREET SIDE:	35' (RECOMMEND BUT NOT REQUIRED)	STREET SIDE:	15'
REAR:	20' MIN. or 1.5X BLDG HT	REAR: (1.5 x 20'=30')	30'
SIDE:	10' MIN. or 1.5X BLDG HT	SIDE:	10'

40% MAX.

36,169 SF

70,965 SF

50.96%

HEIGHT

CURRENT ZONING BUILDING HEIGHT: PROPOSED BUILDING HEIGHT: PROPOSED NUMBER OF STORIES:	45' - 0" 70' - 0" FIVE (5) STORIES ABOVE GRADE TWO (2) STORIES BELOW GRADE

LOT COVERAGE

REQUIRED LOT COVERAGE: PROPOSED LOT COVERAGE (SF) LOT AREA: PROPOSED LOT COVERAGE PERCENTAGE:

OPEN SPACE REQUIREMENT

REQUIRED USABLE SPACE: MIN. 150 SQ FT PER UNIT EXCLUDING SETBACKS REQUIRED LANDSCAPE: 70-80% OF COMMON OUTDOOR SPACE REQUIRED PRIVATE OUTDOOR SPACE: 70-80% OF COMMON OUTDOOR SPACE

REQUIRED USABLE OPEN SPACE: 150 SF X 141 UNITS = 21,150 SF

PROVIDED USABLE OPEN SPACE: COMMON + PRIVATE = 17,800 SF

* SEE SHEET A-202 FOR CALCULATION DIAGRAM

UNIT SUMMARY			
Name	Area	Count	Average SF
S1	6731 SF	14	480 SF
1A	36391 SF	47	781 SF
1A.J	12486 SF	19	657 SF
1B	760 SF	1	760 SF
1C	2551 SF	3	850 SF
1D	2704 SF	4	676 SF
1E	2793 SF	3	931 SF
1F	2794 SF	3	931 SF
2A	27060 SF	25	1082 SF
2B	15596 SF	14	1114 SF
2C	9873 SF	8	1292 SF
Grand total	119739 SF	141	L

PROPOSED TOTAL UNIT COUNT: 141 DU

PROJECT DESCRIPTION:

THE PROJECT SITE IS A 1.63 ACRE PROPERTY WITHIN CITY OF CUPERTINO'S 'HEART OF THE CITY' SPECIFIC PLAN AREA LOCATED AT THE SOUTH-EAST CORNER OF STEVENS CREEK BLVD AND N. BLANEY AVENUE WITH COMMERCIAL BUILDINGS AND PARKING LOT AT ITS WEST, RESIDENTIAL NEIGHBORHOOD AT ITS NORTH. THE PROPOSED DEVELOPMENT IS TO REPLACE THREE EXISTING COMMERCIAL BUILDINGS AND SURFACE PARKING LOTS WITH A MULTI-FAMILY BUILDING. THE RESIDENTIAL BUILDING IS COMPRISED OF FIVE STORIES OF TYPE III-A RENTAL APARTMENTS OVER TWO STORIES OF TYPE I-A SUBTERRANEAN GARAGE.

THE PROGRAM INCLUDES 141 RENTAL UNITS, GROUND LEVEL AMENITIES, A ROOFTOP GARDEN, AND 195 UNDERGROUND PARKING STALLS. WITH ITS TRANSIT-FRIENDLY LOCATION WITHIN 1/2 MILE WALK TO A MAJOR TRANSIT CORNER OF DE ANZA AND STEVENS CREEK THE SITE DESIGN FOCUSES ON CONNECTING THE STREETSCAPE AND BIKE/WALK ACTIVITY WITH ITS SURROUNDING ENVIRONMENT. IT PROPOSED AN ACTIVE STOREFRONT, ICONIC CORNER ARCHITECTURE, INTEGRATED BUS STOP, AND A PEDESTRIAN-FRIENDLY PLAZA AT THE CORNER OF STEVENS CREEK BOULEVARD AND BLANEY AVENUE. A RESIDENTIAL ACCENT WAS FURTHER ENHANCED BY LAYERS OF PLANTERS. STOOPS. BAY WINDOWS. MID-BLOCK LOBBY, AND UPPER LEVEL STEP-BACKS ALONG BLANEY AVENUE. THE BUILDING WAS CONFIGURED WITH A LARGE NORTH-FACING OPEN COURTYARD TO RELIEVE MASSING IMPACT TO NEIGHBORING HOUSES. FURTHERMORE, THE DESIGN PROPOSED A 30 FEE LANDSCAPE SETBACK AND 2-STORY STEP-DOWN MASSING TOWARD THE NORTHERN NEIGHBORHOOD FOR A COMFORTABLE TRANSITION TO LOWER RESIDENTIAL SCALE.

PARKING SUMMARY:

1.0 STALL PER STUDIO & 1BR: 96 UNITS x 1.0	= 96
1.5 STALL PER 2BR & 3BR = 45 UNITS x 1.5	= 68
TOTAL REQUIRED	164

PROPOSED PARKING

195 (1.38 SPACES/UNIT)

	PARKING TYPE		QTY
	9'-0" x 18'-0" ACCESSIBLE	GUEST PARKING	1
	EV CHARGER 18'-0"Dx 9'-0"W	GUEST PARKING	1
	18'-0"Wx8'-6"D	GUEST PARKING	10
	BASEMENT B1 GUEST TOTAL:		12
	9'-0" x 18'-0" ACCESSIBLE	RESIDENTIAL PARKING	4
ы Ш			4
ш	VAN 9'-0" x 18'-0" ACCESSIBLE	RESIDENTIAL PARKING	1
	EV CHARGER 18'-0"Dx 9'-0"W	RESIDENTIAL PARKING	11
	EV READY 18'-0"Dx 9'-0"W	RESIDENTIAL PARKING	49
	EV CAPABLE 18'-0"Dx 9'-0"W	RESIDENTIAL PARKING	20
	18'-0"Wx8'-6"D	RESIDENTIAL PARKING	49
	BASEMENT B1 RESIDENTIAL TOTAL:		134
	18'-0"Wx8'-6"D	RESIDENTIAL PARKING	49
B 2	BASEMENT B2 RESIDENTIAL TOTAL:		49
	GRAND TOTAL:		195

12 GUEST STALLS + 183 RESIDENCE STALLS = **<u>195</u>** TOTAL STALLS 1 ACCESSILBE GUEST PARKING REQUIRED (12 TOTAL STALLS X 5% = 1 STALL) 4 ACCESSIBLE RESIDENTIAL PARKING REQUIRED (183 TOTAL STALLS X 2% = 4 STALLS) 5 ACCESSIBLE PARKING STALLS REQUIRED 6 ACCESSIBLE PARKING PROVIED

2022 CALGREEN EV REQUIREMENTS:				
TYPE	REQUIREMENTS	REQUIRED #	PROPOSED #	
EV CAPABLE ¹	10% OF PARKING SPACES	20	20	
EV READY ²	25% OF PARKING SPACES	49	50	
EV CHARGERS ³	5% PARKING SPACES	10	10	

I. EV CAPABLE. PROVIDE ELECTRICAL PANEL SPACE, EMPTY CONDUIT (NO WIRE), AND A TERMINATION BOX FOR FUTURE 120V, 40A.

2. EV READY. FULLY WIRED AND READY TO USE 208/240V, 40A OR CHARGING STATION.


3. EV CHARGERS. FULLY WIRED AND READY TO USE 208/240V, 40A STAND-ALONE

CHARGERS. AT LEAST 1 SHALL BE LOCATED IN THE COMMON USE PARKING AREA.

BIKE PARKING

1 BIKE STALL PER 2 UNITS REQUIRED

141 UNITS X .5 = **70.5 BIKE STALLS REQUIRED** 71 STALLS PROVIDED

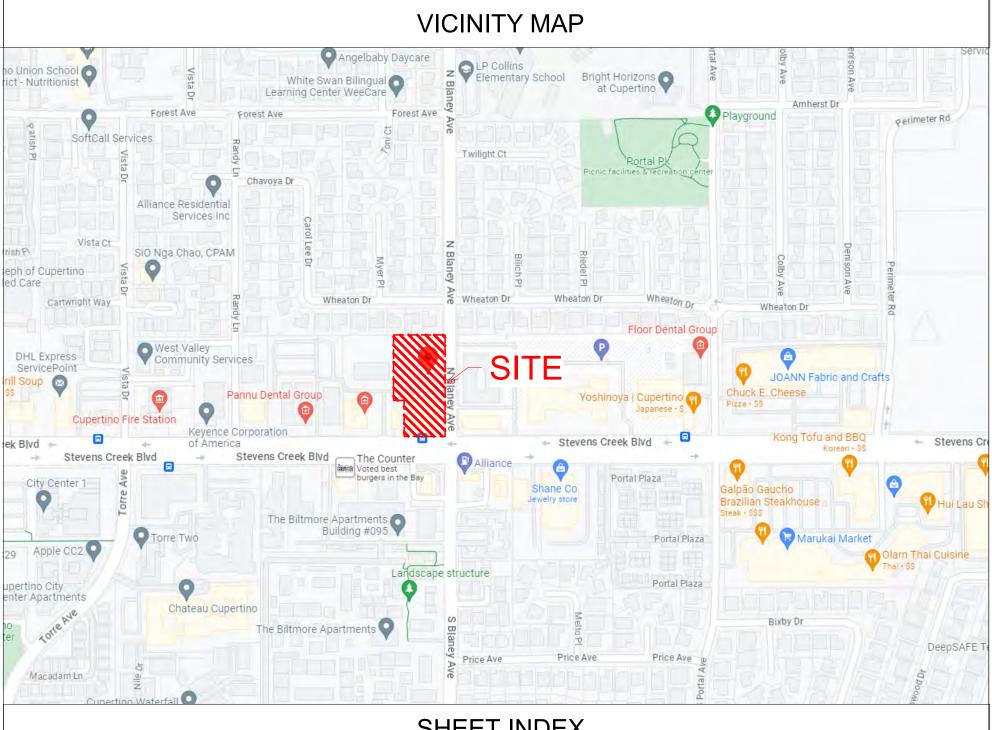

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G000	COVER SHEET	02_CIVIL C-1.0	EXISTING CONDITIONS PLAN
G000 G100	PROJECT INFORMATION	C-1.0 C-2.0	CONCEPTUAL GRADING AND DRAINAGE
G200	EXISTING SITE PHOTOS	C-2.0	PLAN
G200 G300	SITE CONTEXT	C-3.0	PRELIMINARY UTILITY PLAN
G300 G400	ILLUSTRATIVE SITE PLAN	C-4.0	CONCEPTUAL STORMWATER CONTROL
G400 G500	URBAN DESIGN CONCEPT IMAGERY	0 110	PLAN
G500 G600	CONTEXT MAP	C-4.1	STORMWATER CONTROL PLAN NOTES
G000 G700	SITE PLAN		
G700	SHEFLAN	03_JOINT	TRENCH
	TECTURAL	JT-1	JOINT TRENCH TITLE SHEET
A100	AERIAL VIEW AT STEVENS CREEK AND	JT-2	JOINT TRENCH INTENT
Aloo	BLANEY		
A101	FLOOR PLAN - BASEMENT B2	04_LANDS	SCAPE
A102	FLOOR PLAN - BASEMENT B1	L1.1	LANDSCAPE PLAN- GROUND LEVEL
A103	FLOOR PLAN - GROUND LEVEL	L1.2	PLANTING PALETTE AND FEATURE
A104	FLOOR PLAN - LEVEL 2		REFENCE IMAGERY
A105	FLOOR PLAN - LEVEL 3	L1.3	PRELIMINARY PLANTING PLAN
A106	FLOOR PLAN - LEVEL 4	L1.4	LANDSCAPE SECTIONS
A107	FLOOR PLAN - LEVEL 5	L1.5	RENDERING
A108	ROOF PLAN	L1.6	RENDERING
A200	FIRE ACCESS DIAGRAM	07_TRASH	
A201	FIRE WALL AND EXIT STUDY	TR0.1	SITE PLAN LEVEL-1
A202	OPEN SPACE CALCULATION	TR0.2	SITE PLAN LEVEL-3
A300	SOUTH ELEVATION AND PERSPECTIVE	TR0.3	STAGING
A301	EAST ELEVATION AND PERSPECTIVE	TR1.0	RESIDENTIAL TRASH ROOM
A302	NORTH ELEVATION AND PERSPECTIVE	TR1.1	UPPER VESTIBULE - LEVELS 2-5
A303	WEST ELEVATION AND PERSPECTIVE		
A304	MATERIALS AND COLORS		
A401	BUILDING SECTIONS		
A410	WALL SECTION		
A411	WALL SECTION		
A412	WALL SECTION		
A600	RENDERING AT NORTH-EAST CORNER		
	PRO.IF	CT TFAM	

OWNER

20015 SCB CUPERTINO MULTI, LLC 20015 STEVENS CREEK BOULEVARD CUPERTINO, CA 95014 CONTACT: GARY JOHNSON GARY@ACCLAIMCOMPANIES.COM 650.622.2107

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CIVIL: HMH

1570 OAKLAND ROAD SAN JOSE, CA 95131 CONTACT: DEENA MORSILLI DMORSILLI@HMHCA.COM 669.221.7817

LANDSCAPE: PLAT STUDIO

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SHEET INDEX

PROJECT LEAM



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- Planning
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ELECTRICAL ENGINEER:

TRASH CONSULTANT: AMERICAN TRASH MANAGEMENT. INC 1900 POWELL STREET, SUITE 220 EMERYVILLE, CA 94608 CONTACT: DAISY URBINA DAISYURBINA@TRASHMANAGE.COM 510.607.7602

JOINT TRENCH: **RADIUS DESIGN** 1460 MARIA LANE #420, WALNUT CREEK, CA 94596 CONTACT: MICHAEL COLE MCOLE@RADIUSJT.COM 669.221.7817

Sheet Title: PROJECT **INFORMATION**

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23004 9/26/2023 1/4" = 1'-0"

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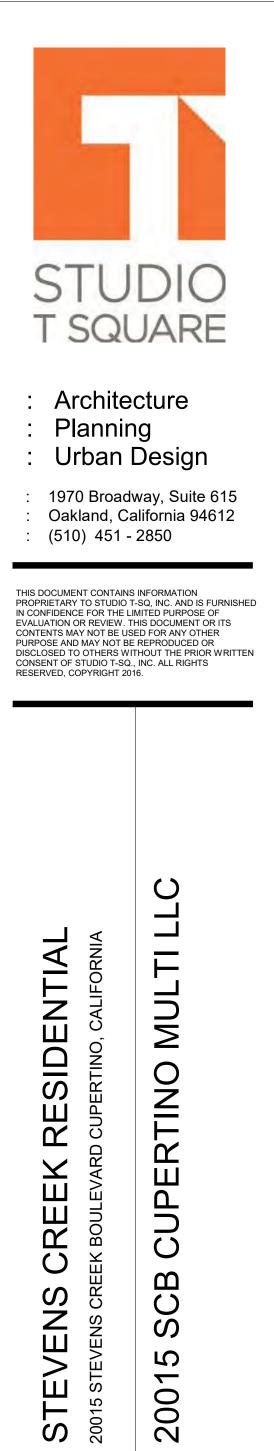












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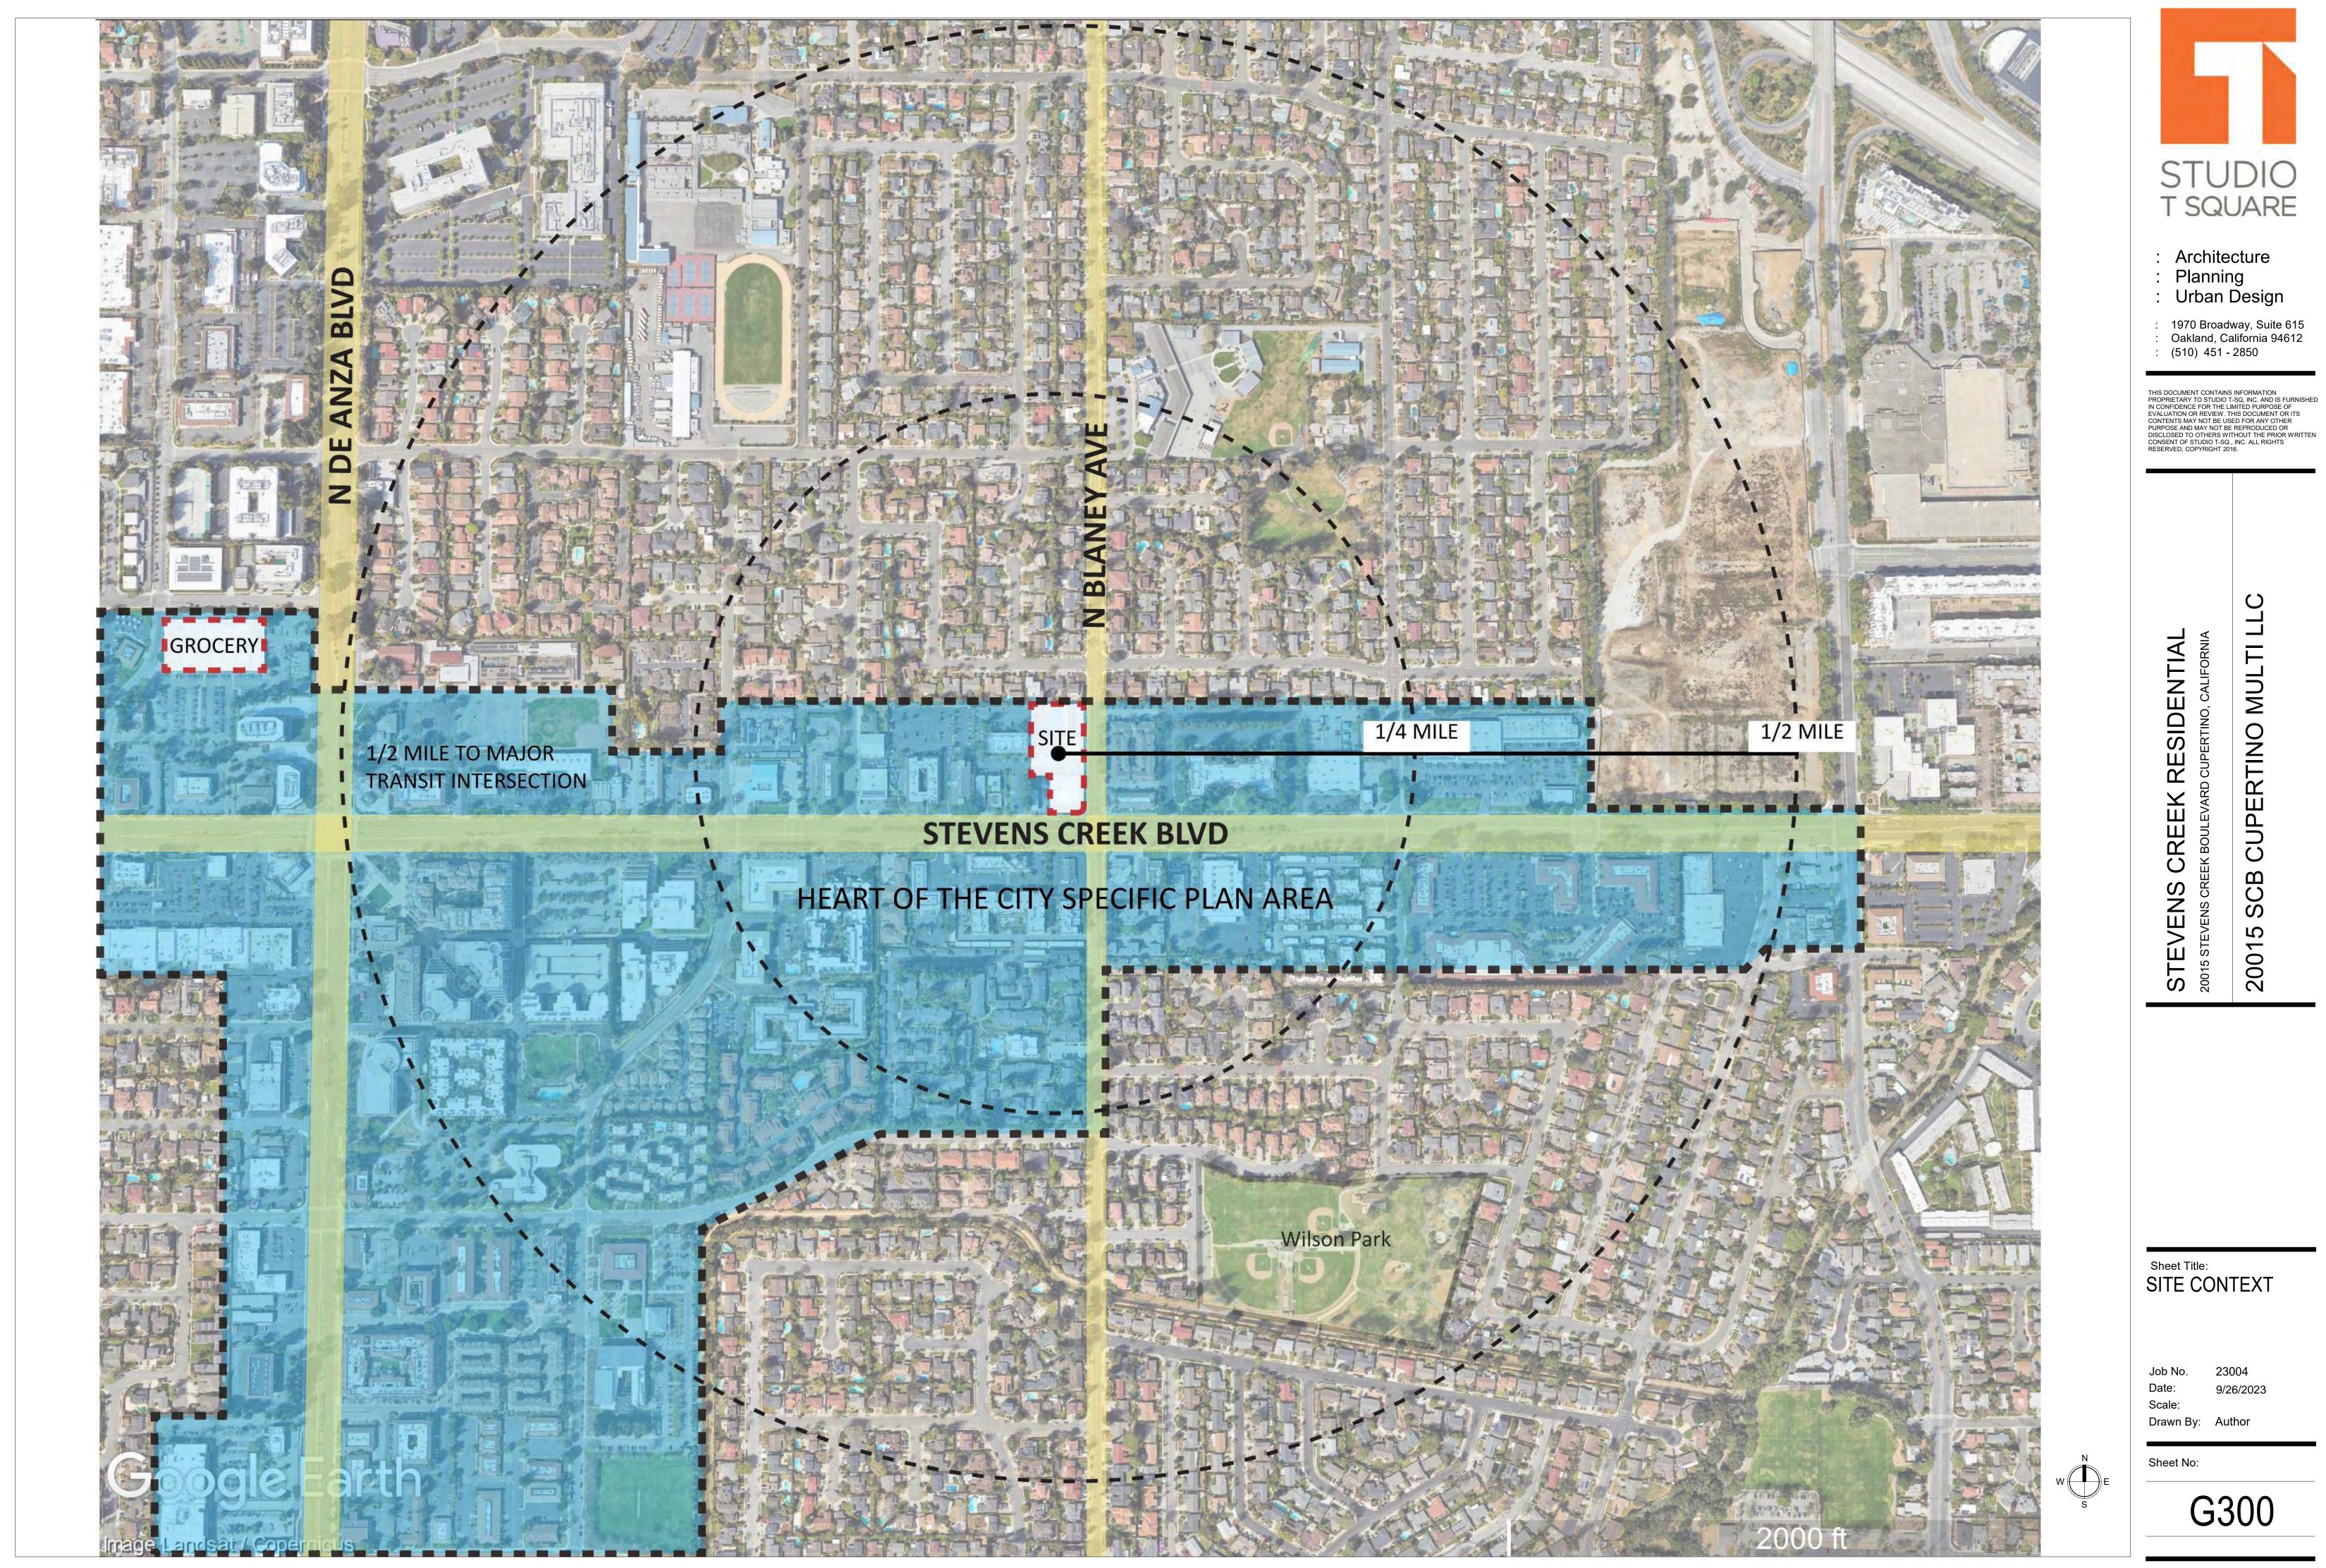
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Sheet Title: PLAN


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ROOF TERRACE TO RELIEVE UPPER LEVEL MASSING AT THE CORNER



CORNER PLAZA WITH WELCOMING LANDSCAPE FEATURES



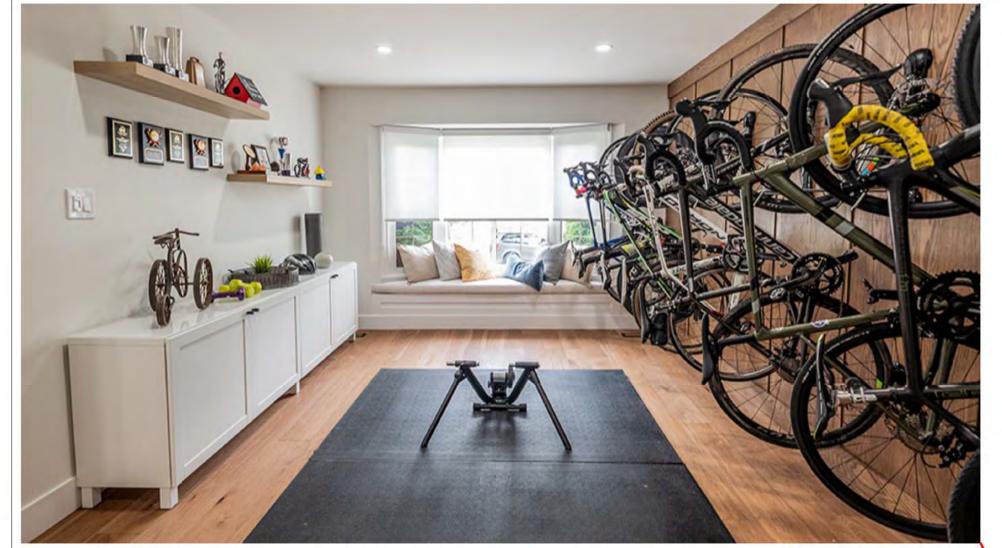


MAINTAINING RESIDENTIAL SCALE BY BROKEN-UP MASSING AND UPPER LEVEL STEP-BACK







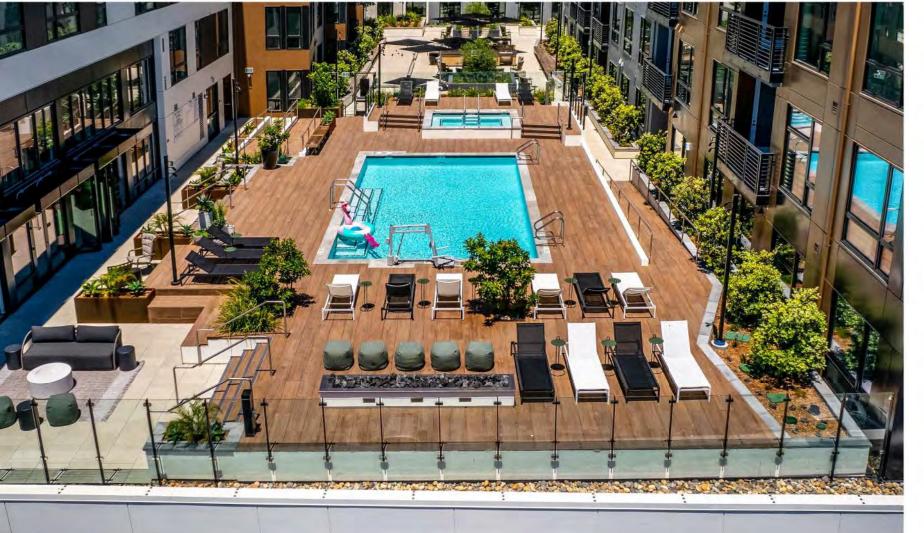

COURTYARD OPEN SPACE PROVIDES ATTRACTIVE AND SOOTHING VISUAL RELIEF



STEP-DOWN MASSING TRANSTION TO RESIDENTIAL NEIGHBORHOOD

BAY WINDOWS AND STOOP ENTRY TO ENHANCE BLANEY'S SENSE OF COMMUNITY



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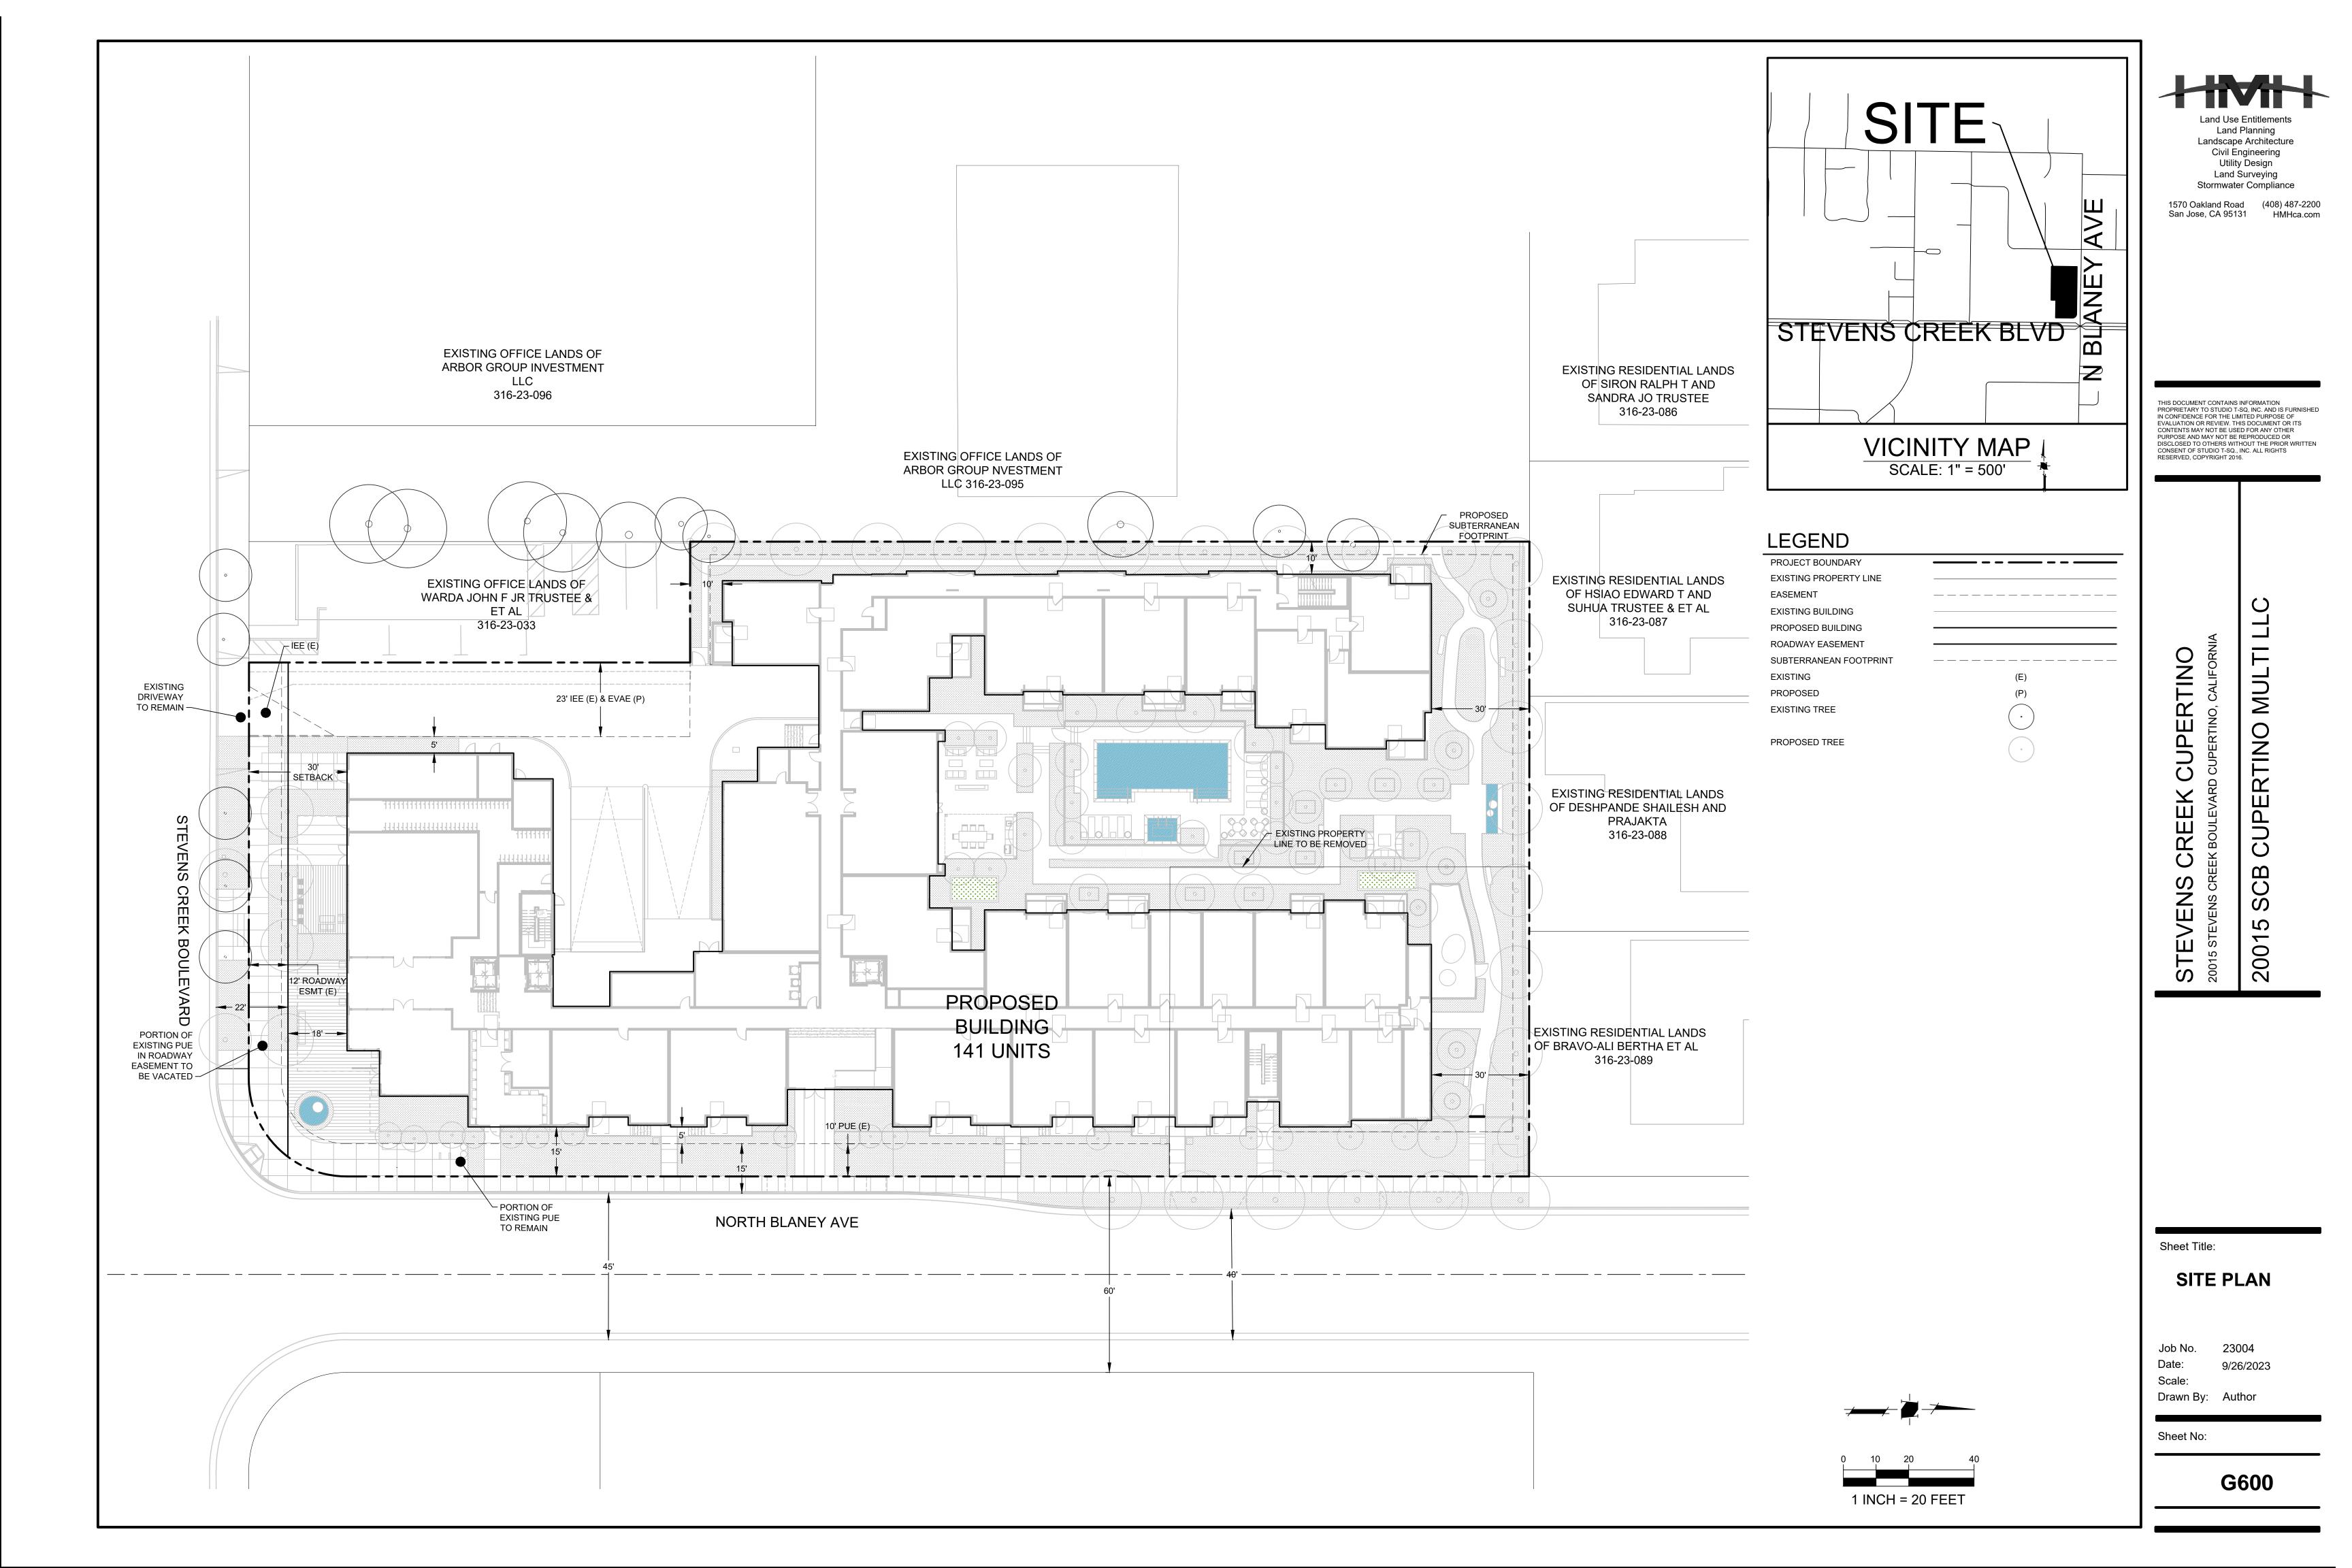
Sheet Title: URBAN DESIGN CONCEPT IMAGERY

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23004 9/26/2023 1" = 40'-0"

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CORTEN STEEL





MATERIAL LEGEND

- 1. GLASS RAILING
- 2. METAL RAILING
- 3. PERFORATED METAL RAILING
- 4. VINLY WINDOW
- 5. METAL SUNSHADE
- 6. SLATE CONCRETE ROOF
- 7. STOREFRONT
- 8. FIBER CEMENET VERTICAL PANEL COLOR 1
- 9. FIBER CEMENET VERTICAL PANEL COLOR 1
- 10. WOOD-LIKE HORIZONTAL PANEL
- 11. PLASTER COLOR 1
- 12. PLASTER COLOR 2
- 13. CULTURE STONE VENEER
- 14. METAL PANEL
- 15. WOODEN SCREEN



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AND PERSPECTIVE

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9/26/2023 1/16" = 1'-0"



ROOF PARAPET 62' - 6"
 LEVEL 5 46' - 6"
 <u>LEVEL 4</u> 36' - 4"
 <u>LEVEL 3</u>
 <u>LEVEL 2</u> 16' - 0"
 LEVEL 1 4' - 0" G.F. LEVEL 0' - 0"

	5	0	5	10	15	20	25
1/16" = 1'-0							T
SCALE			=		FEET		



MATERIAL LEGEND

8. FIBER CEMENET VERTICAL PANEL COLOR 1


9. FIBER CEMENET VERTICAL PANEL COLOR 1

10. WOOD-LIKE HORIZONTAL PANEL

- 1. GLASS RAILING



6. SLATE CONCRETE ROOF

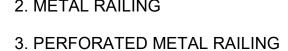

- 2. METAL RAILING

4. VINLY WINDOW

7. STOREFRONT

5. METAL SUNSHADE

11. PLASTER COLOR 1


12. PLASTER COLOR 2

14. METAL PANEL

BAY WINDOWS

15. WOODEN SCREEN

13. CULTURE STONE VENEER

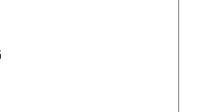



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	P.L. 	ROOF	PARAPET 62'- 6"
 			<u>ROOF</u> 58' - 6"
		20'- 0" 58'- 6" TOP OF PARAPET	$\frac{\text{LEVEL 5}}{46' - 6''}$ $\frac{\text{LEVEL 4}}{36' - 4''}$ $\frac{\text{LEVEL 3}}{26' - 2''}$ $\frac{\text{LEVEL 2}}{16' - 0''}$ $\frac{\text{LEVEL 1}}{4' - 0''}$ $5.F. \text{LEVEL 1}$ $0' - 0''$

5 0 5 10 15 20 25 1/16" = 1'-0" SCALE FEET

1/16" = 1'-0"

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MATERIAL LEGEND

- 3. PERFORATED METAL RAILING

- 8. FIBER CEMENET VERTICAL PANEL COLOR 1
- 9. FIBER CEMENET VERTICAL PANEL COLOR 1
- 10. WOOD-LIKE HORIZONTAL PANEL

- 13. CULTURE STONE VENEER

	5	0	5	10	15	20	25
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